



WEDGE LOOSE STRAW  
BETWEEN BALES.

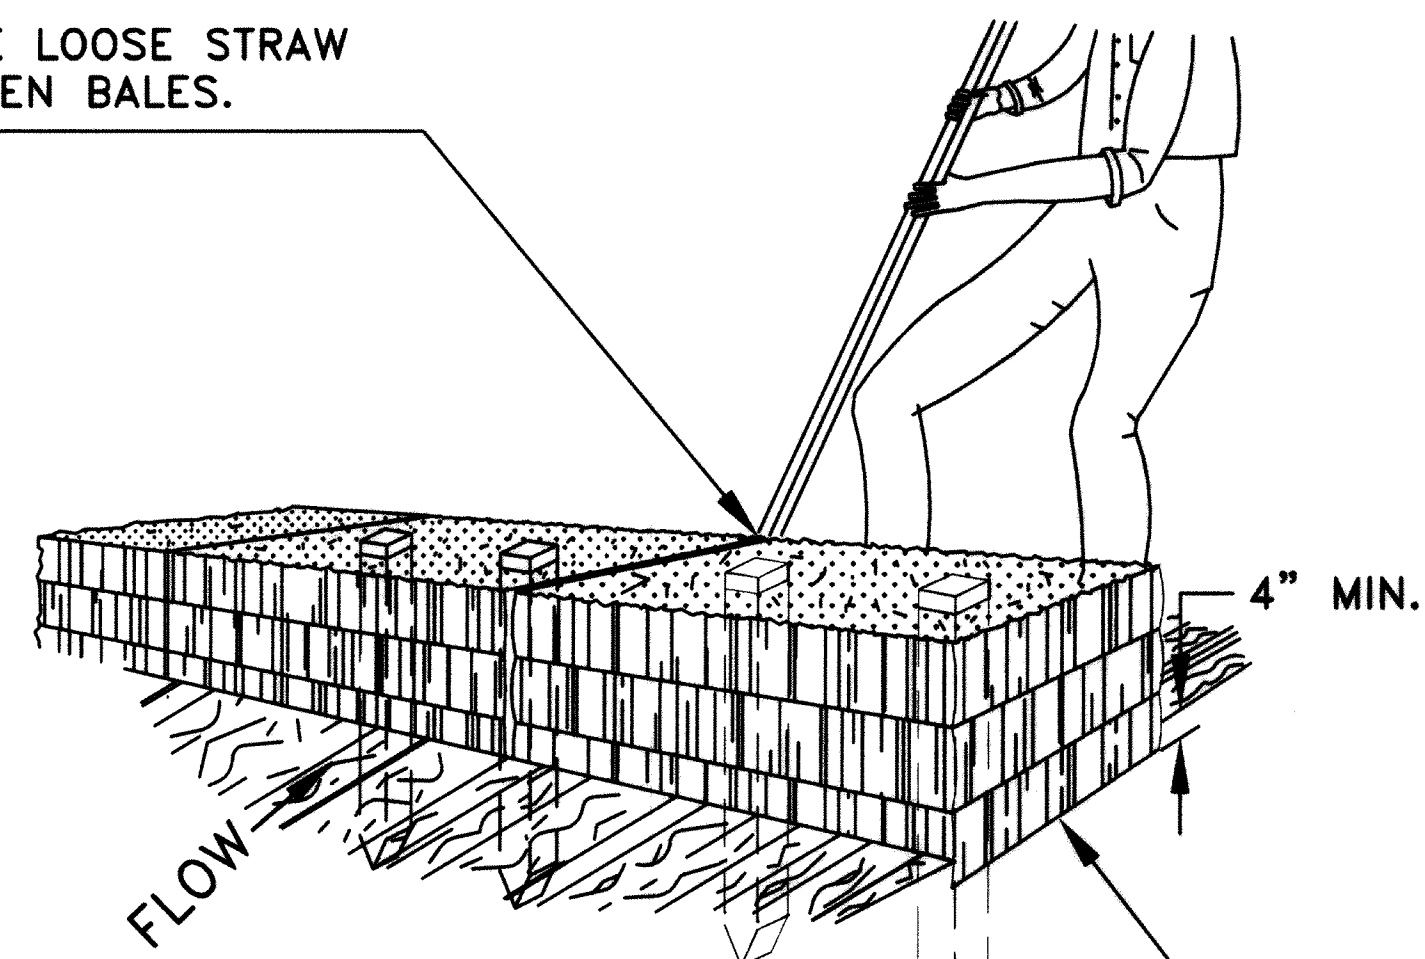

EXCAVATE TRENCH  
WIDTH FOR BALE


PLACE AND STAKE  
STRAW BALES

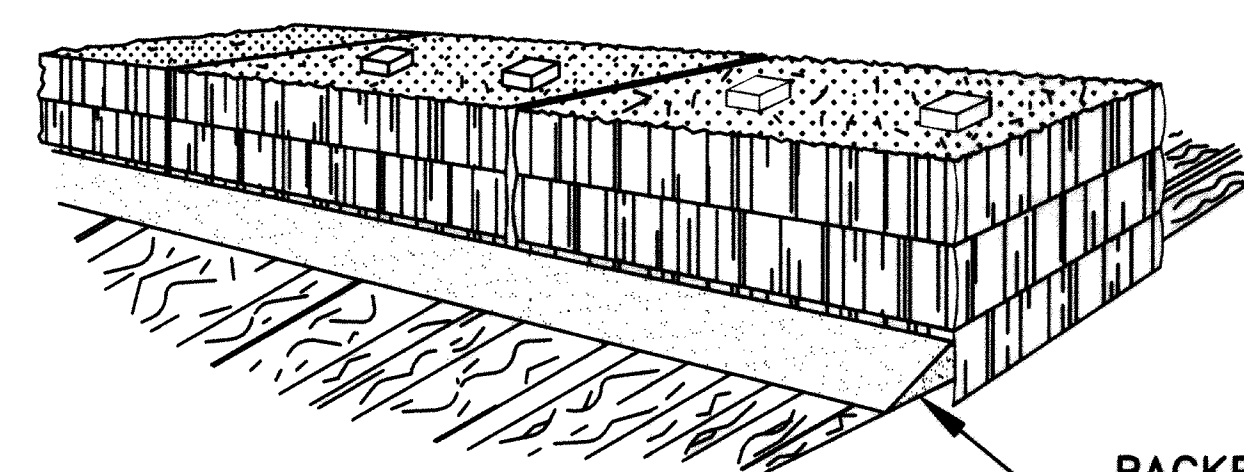

BACKFILL AND COMPACT  
THE EXCAVATED SOIL.


### STRAW BALE BARRIER

NOT TO SCALE

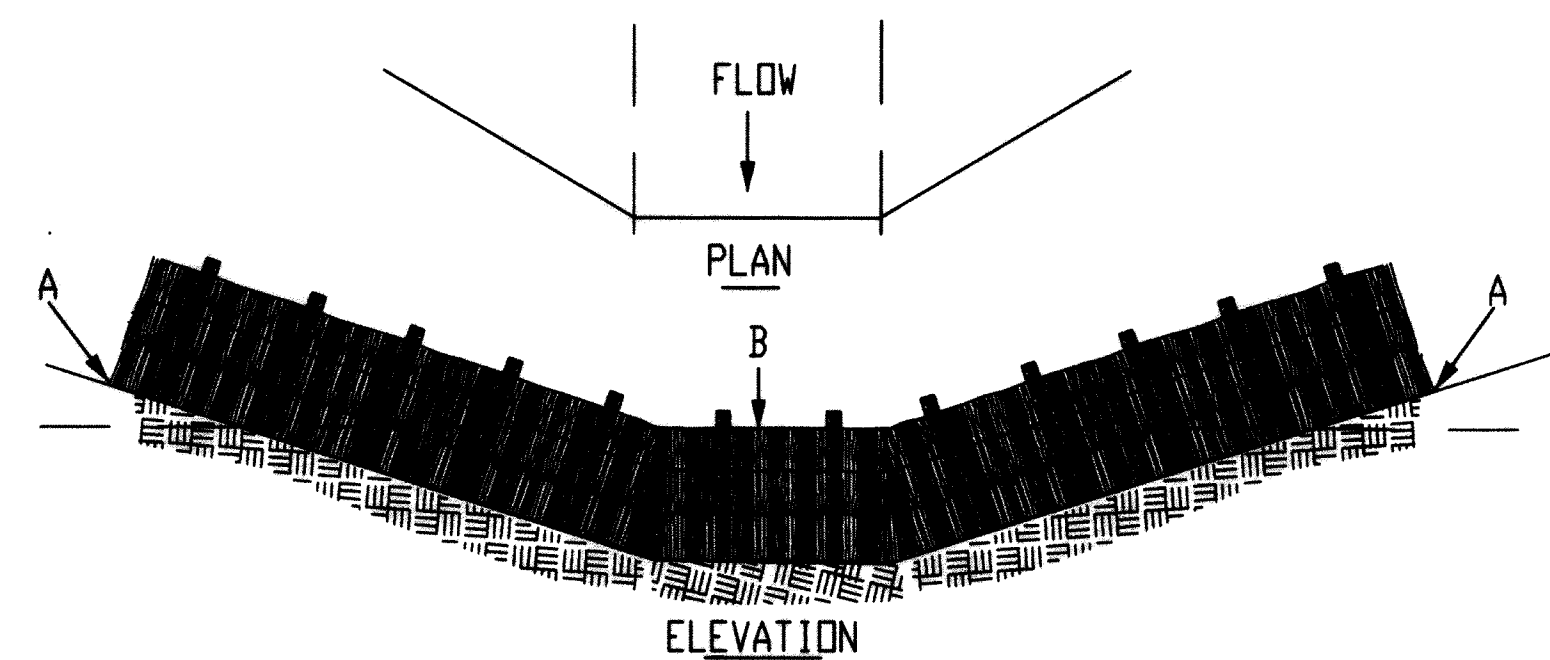


### PLACEMENT OF STRAW BALE BARRIER

SCALE: NTS

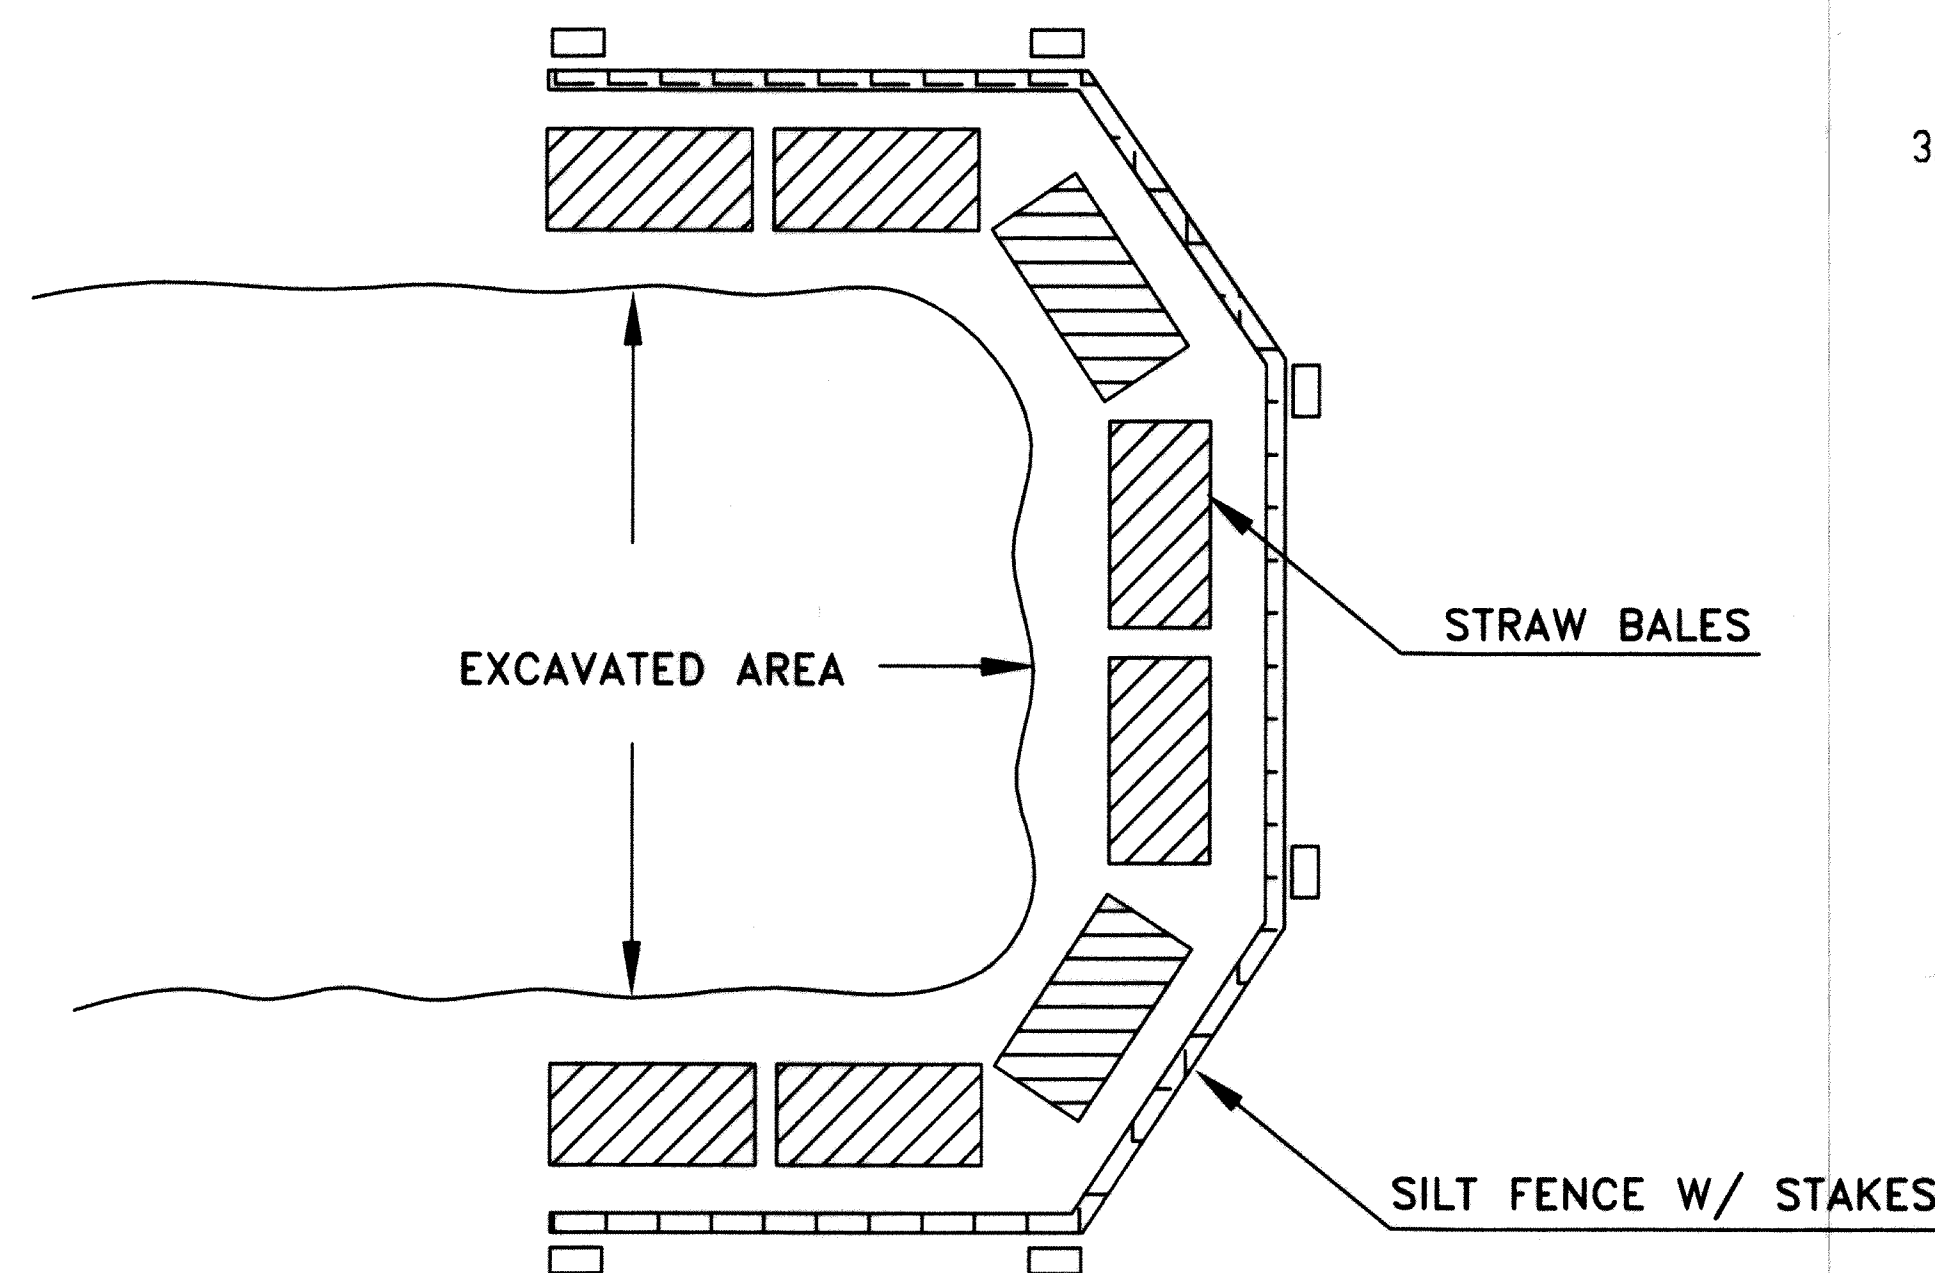


### SEDIMENT TRAP

SCALE: NTS

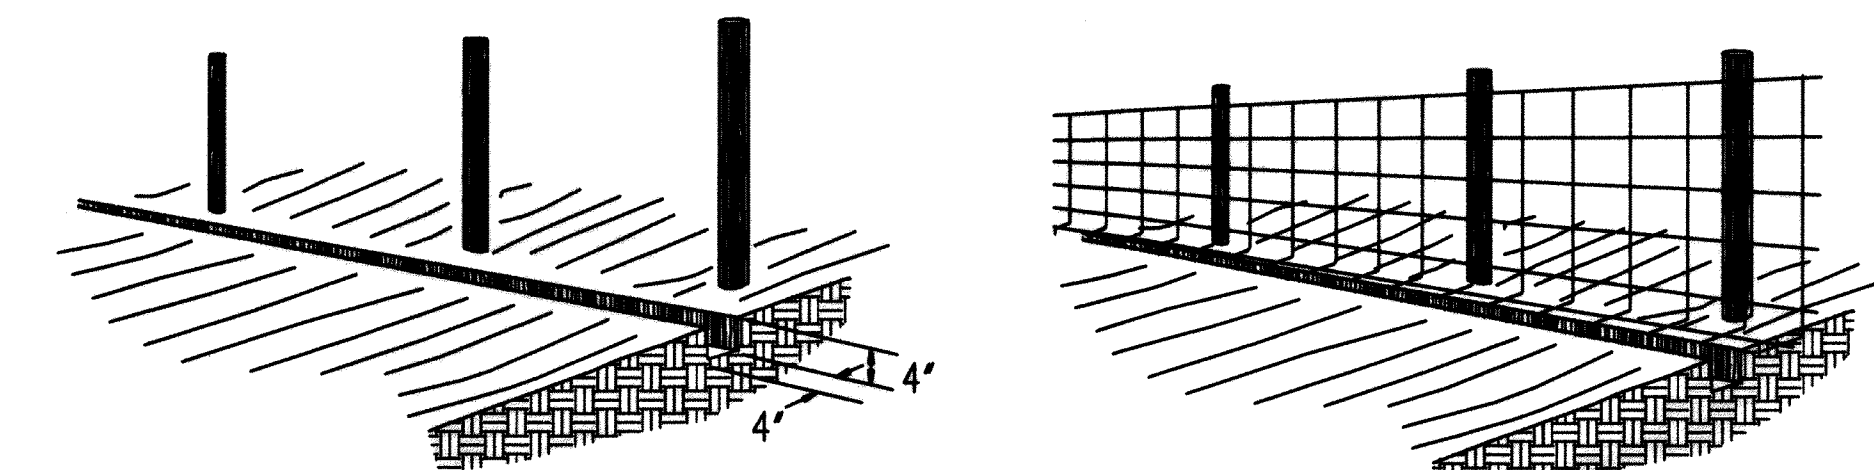


1. SET POSTS AND EXCAVATE A 4' X 4' TRENCH  
UPSLOPE ALONG THE LINE OF POSTS

2. STAPLE WIRE FENCEING TO THE POSTS

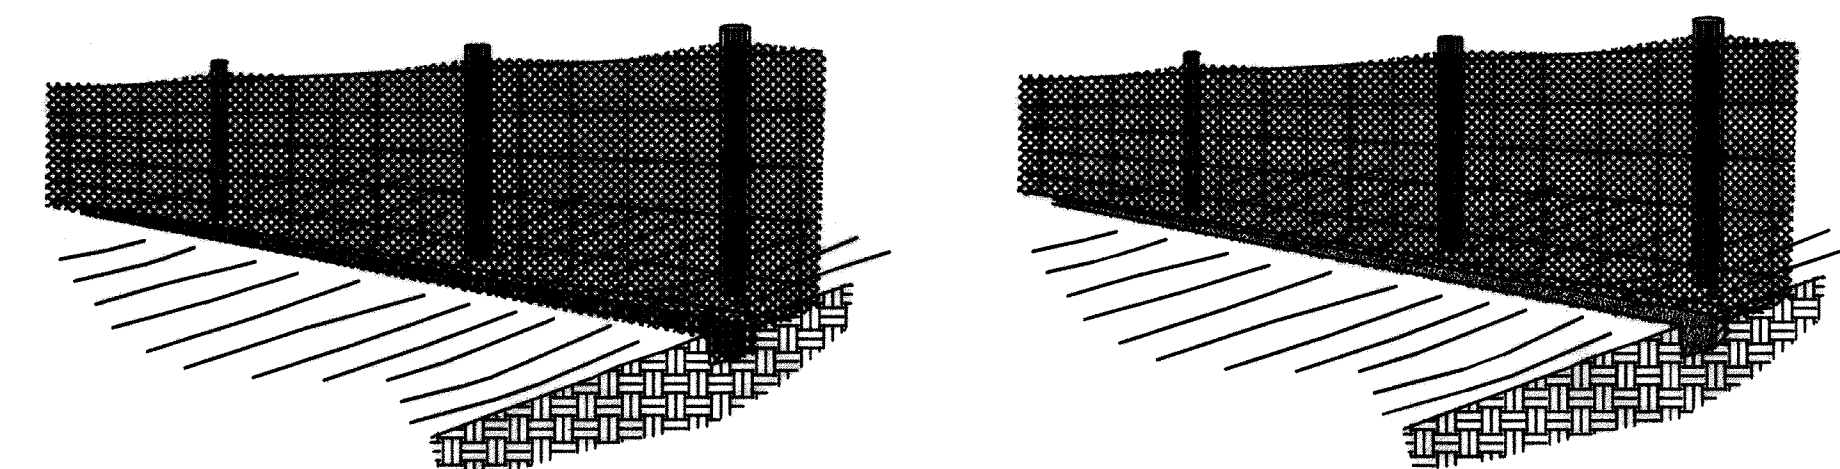

3. ATTACH THE FILTER FABRIC TO THE WIRE FENCE  
AND EXTEND IT INTO THE TRENCH

4. BACKFILL AND COMPACT THE EXCAVATED SOIL

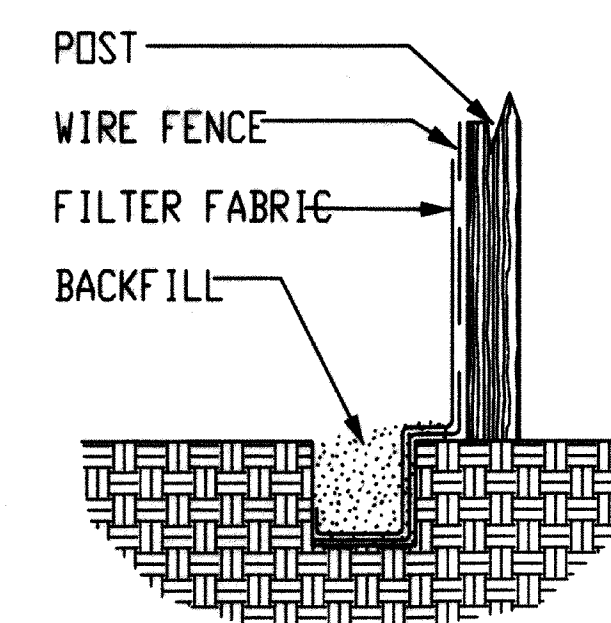


EXTENSION OF FABRIC AND WIRE INTO THE TRENCH

### SILT FENCE CONSTRUCTION PROCEDURES

SCALE: NTS

BURIED TELEPHONE CABLES AND UTILITIES  
CALL: TENNESSEE ONE CALL (1-800-351-1111)

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NO.	DESCRIPTION	DATE	BY
REVISIONS			

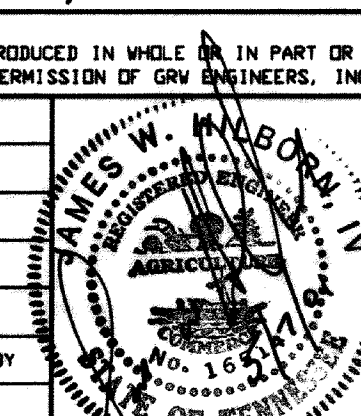

GRW PROJECT NO. 7408

PERRY COUNTY  
LOBELVILLE, TENNESSEE  
WATER LINE EXPANSION  
EROSION CONTROL MEASURES

**GRW**  
GRW Engineers, Inc.  
Engineers, Architects, Planners  
LEXINGTON LOUISVILLE NASHVILLE INDIANAPOLIS

DESIGNED: DLT	DATE: MAY, 2001
DRAWN: DLT	SCALE: NO SCALE
REVIEWED: EEM	SHEET NO.
APPROVED: JWH	C-5